





3 - GREEN / ART WALL PERSPECTIVE

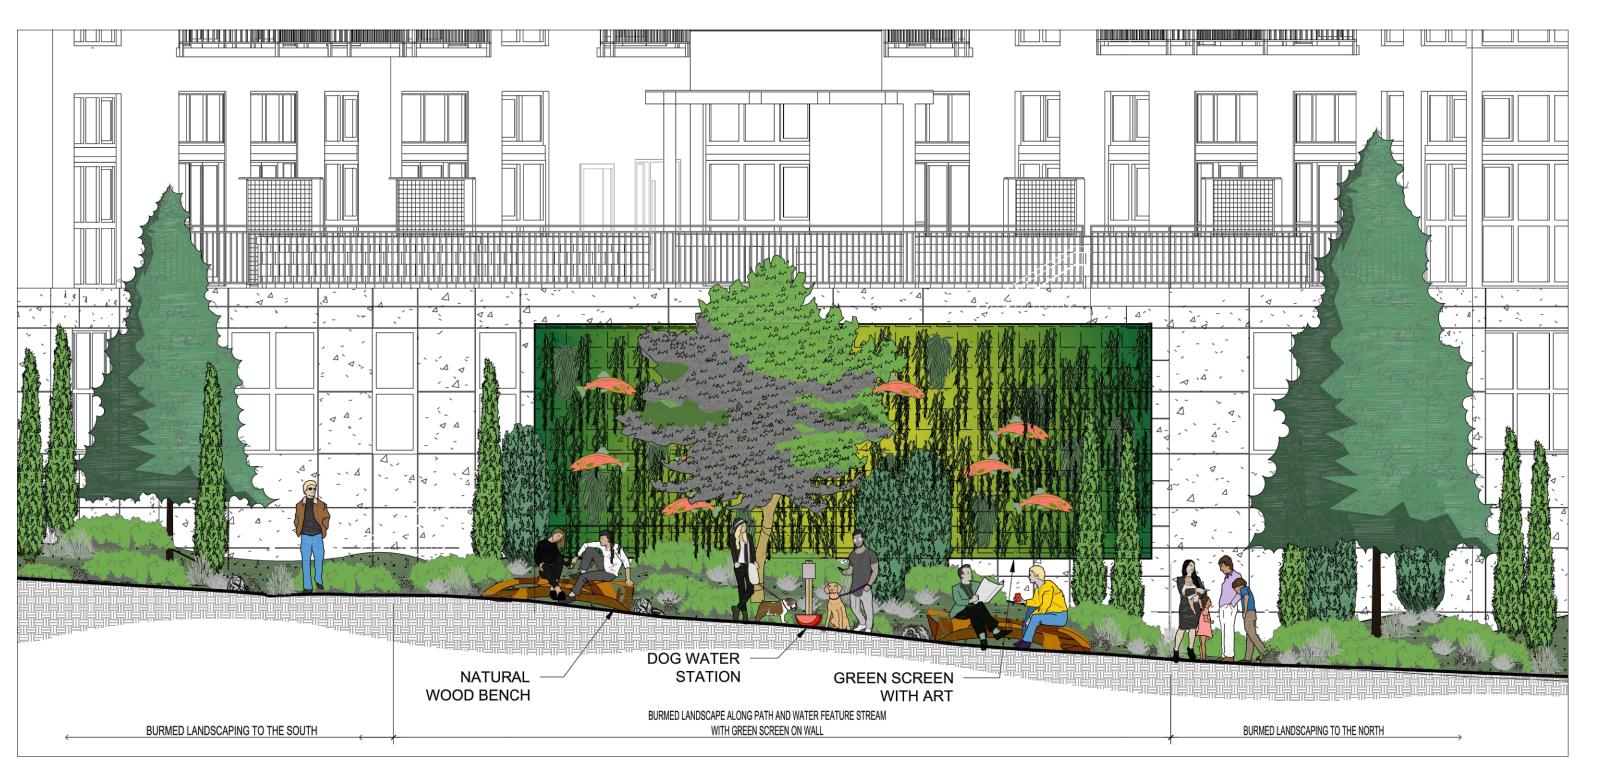

4 - EAST ELEVATION



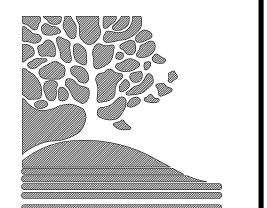

THOMAS RENGSTORF AND ASSOCIATES

LANDSCAPE ARCHITECTURE
SITE PLANNING

URBAN DESIGN

PHONE: (206) 682-7562

SUITE 400, 811 FIRST AVE., SEATTLE, WA 98104



MILANO ISSAQUAH APARTMENTS

2300 Newport Way, Issaquah WA 98027 ISSAQUAH, WA

QUEET TITI E

# THROUGH BLOCK COMMUNITY SPACE CALLOUT PLAN

No.	DATE	REVISION	ВҮ
$\triangle$	4/4/2022	PERMIT REVISON	BTS
$\triangle$			
$\Delta$			


TE JUNE 7, 2021

DESIGNED TVR
DRAWN BTS
CHECKED TVR
CCALE AS SHOWN
CRA No. 2109
CAD FILE

PROJECT Milano Issaquah Apatments

SHEET No.

L1.01

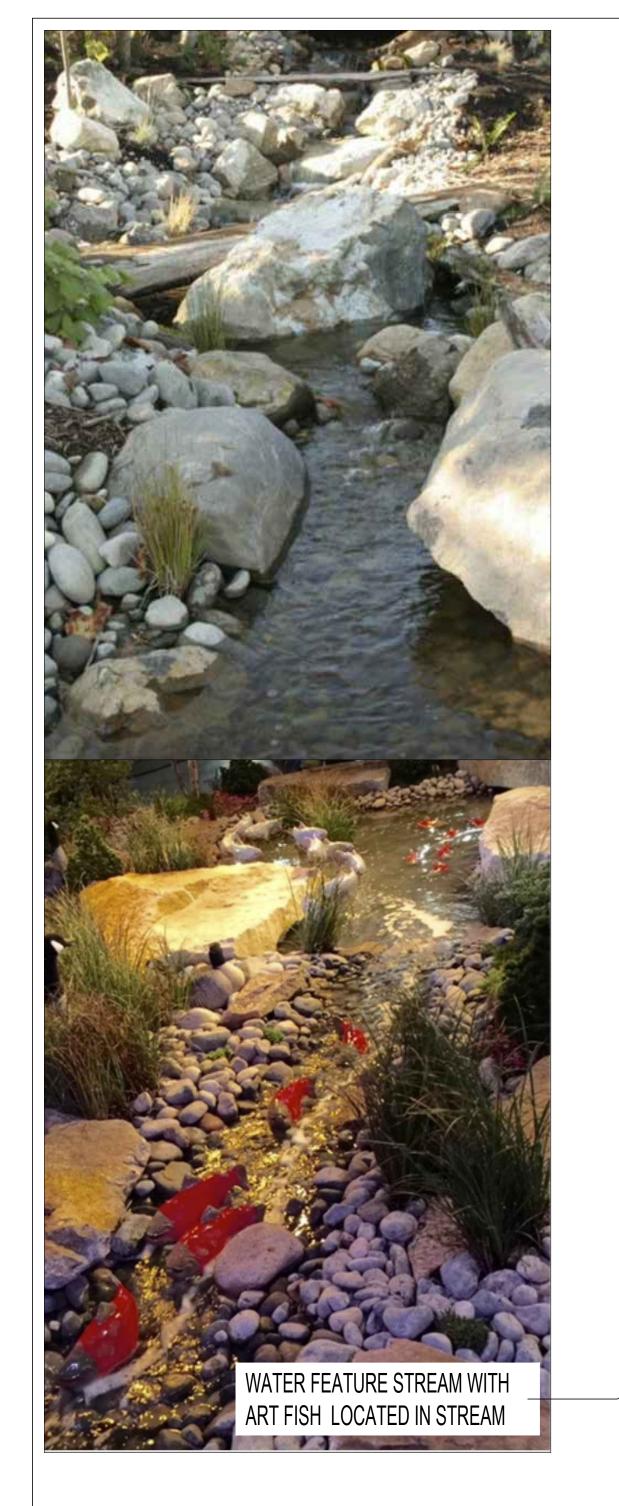










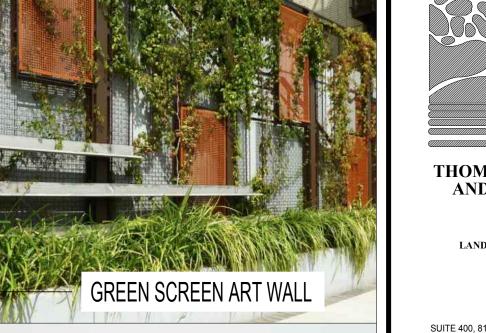





"This stream, and many others in the Lake Washington/Cedar River Watershed, of which Lake Sammamish is a part, is essential to supporting and sustaining salmon populations that are important to, and are shared by, all peoples of the Pacific Northwest."



**ENVIRONMENTAL AND** 

INTERPRETIVE SIGNAGE

							_ 	AA.IO	R MI	RΑ	TORS	SIGI	NAGE
					The Majo	or Migrat	ors	11 10 C	1 1 11111	)			1/ \OL
Chinook (King) Salmon			Coho (Silver) Salmon				Sockeye (Red) Salmon				Journe		
Chinook enter the se they are one year o emain at sea for thr ears before migrati fresh water to spaw Chinook pass throug ladder between Ju	Ocean Phase: inook enter the sea before inook enter the sea before inook enter the sea before inook enter the sea for three or four ins before migrating back to esh water to spawn. Adult inook pass through this fish ladder between fully and lovember Most spawn in October.		Ocean Phase: Coho migrates to sea between one and two years of age. They remain at sea for only 18 months before beginning their migration back to fresh water to spawn. Adult coho pass through this fish ladder between August and late November. They spawn between October to December.		e soon uces the ping Adu ie this and I	Ocean Phase: Sockeye try migrate to ales soon after hatching. They stay there for one or two years. Adult sockeyes pass through this fish ladder between June and late October. They spawn from September to November.		Spawning Phase: Spawning sockeyes experience the most pronounced changes of all salmon. Their bodies become bright red to dull gray- red and their heads turn bright green to olive. Their snouts turn black and their lower jaw turns grayish. Males develop a type and hump on their backs.		4			
SO S	$\prec$	STATE OF THE PARTY	M	30)						*	T		
Pink (Humpback) Salmon			Chum (Dog) Salmon				Steelhead				98		
Ocean Phase:  Spawning Phase:  Milkspan of all Pacific Salmon,  living just two years. They paym between June amd late October. They stay relatively  close to their river's mouth to spawn due to their short  lifespan.		Ocean Phase: Chum may spend up to seven years at sea, but typically four. They begin migrating after mid-June and end up reaching their spawning area in November or December.		Chum characteri purple vert of the boo the spay males an	Spawning Phase: Chum salmon display characteristic olive-green and purple vertical bars on the sides of the body as they approach the spawning phase. Both males and females develop hooked noses and large canine-		they are two years old. They then migrate to the sea between April and June. They stay at sea about		Spawning stee darker colored distinct red ba not develop a l	Spawning Phase: Spawning steelhead become darker colored and develop a distinct red band. Males do not develop a kype, but their lower jaws become extended.			
									V				(ESE
				U	pstream N	/ligration	Chart						2
Species	Jan	Feb	March	April	May	June	July	Aug	Sep	Oct	Nov	Dec	1
Chinook (King)							*	を発		Ξ.~.	**		
Coho (Silver)								**	* <b>*</b> ***	*	* *		
Sockeye (Red)						<del></del> -	サササ	ŧ‡	**	+	1-pftr  -		
ink (Humpback)						***	**	*	**	***			At ev
Chum (Dog)									hydro hy	***	- m- ,	**	salmor

A DIFFICULT JOURNEY AND

THOMAS RENGSTORF AND ASSOCIATES

> LANDSCAPE ARCHITECTURE SITE PLANNING URBAN DESIGN

SUITE 400, 811 FIRST AVE., SEATTLE, WA 98104 PHONE: (206) 682-7562



**ISSAQUAH APARTMENTS** 

2300 Newport Way, Issaquah WA 98027 ISSAQUAH, WA

THROUGH BLOCK **CALLOUT PLAN** 

No.	DATE	REVISION	BY

4/4/2022 PERMIT REVISON BTS




OJECT NUMBE *19070* 

SHEET

### DETAIL: PLANTING TREE


SOURCE: CITY OF ISSAQUAH

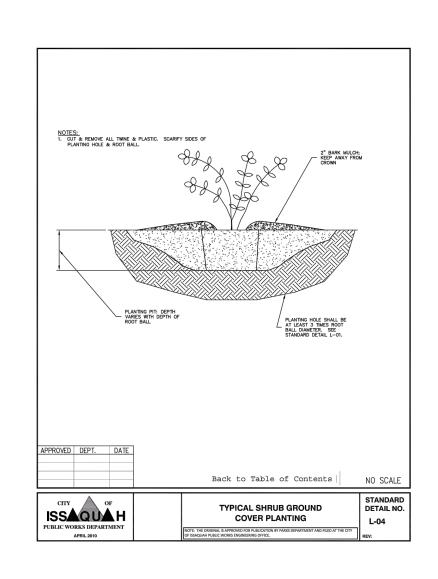

#### **DETAIL: PLANTING SHRUB**


SOURCE: CITY OF ISSAQUAH

NOT TO SCALE

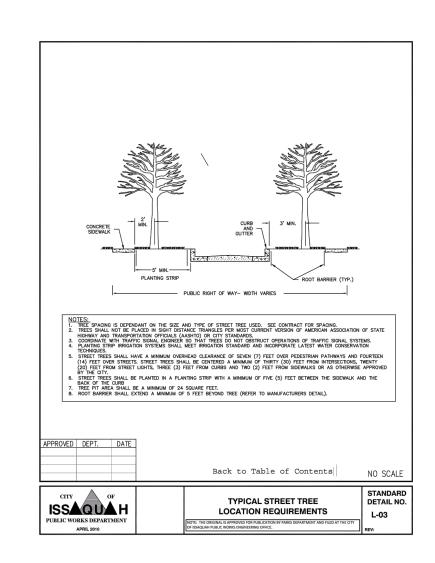

#### **DETAIL: PLANTING STREET TREES**

SOURCE: CITY OF ISSAQUAH

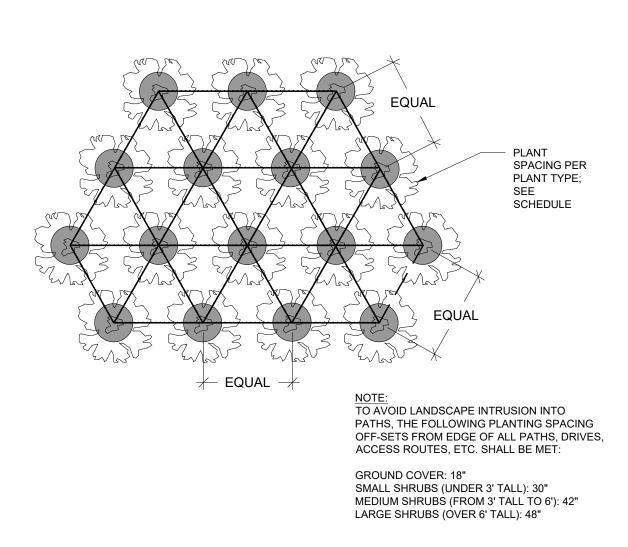

# DETAIL: SHRUB AND GROUND COVER SPACING

SOURCE: CITY OF ISSAQUAH



#### ENLARGEMENT - R.O.W. AND BUILDING FRONTAGE LANDSCAPE TYPICAL SCALE: 1" = 10'

## PLANT SCHEDULE (R.O.W. AND BUILDING FRONTAGE WITHIN SIGHT LINES)

ALL PLANT MATERIALS WITHIN SIGHT TRIANGLE TO BE MAINTAINED AT 3'-6" HT. MAX., PER CITY OF ISSAQUAH STREET STANDARDS (DESIGN STANDARDS, D.2.B.1)

**BOTANICAL NAME** 

KELSEY'S DWARF RED TWIG DOGWOOD CORNUS SERICEA 'KELSEYI'

PIERIS JAPONICA 'MOUNTAIN FIRE' MOUNTAIN FIRE JAPANESE PIERIS

GROUND COVERS BOTANICAL NAME COMMON NAME

ARCTOSTAPHYLOS UVA-URSI KINNIKINNICK

LAVANDULA ANGUSTIFOLIA 'HIDCOTE BLUE' HIDCOTE BLUE ENGLISH LAVENDER

ONLY SHEETS WITH AUTHORIZING SIGNATURES HAVE BEEN APPROVED FOR CONSTRUCTION

SWXX-XXXXX

NOT TO SCALE SOD OR SEED LAWN INSTALL ROOT BARRIER ON ONE OR BOTH SIDES AS NECESSARY DWARF RED TWIG MOUNTAIN FIRE ROTOTILL TOPSOIL INTO -UNDERLYING LAYYER NOTE:

1. INSTALL PRODUCT PER MANUFACTURER'S SPECIFICATIONS.

2. INSTALL PRODUCT A MINIMUM OF 3' BEYOND CENTER OF TREE IN EACH DIRECTION PARALLEL TO UTILITY LINE.

3. ALL TREES LOCATED WITHIN CLOSE PROXIMITY TO UTILITIES TO RECEIVE ROOT BARRIER. APPROVED DEPT. DATE TOP SOIL REQUIREMENTS FOR ISSAQUA H COMPACTED AND
NON-COMPACTED SOILS
OSSEML S APPRODE FOR PRELICATION BY PARKS EDPARTMENT AND FILED AT THE CITY
FRENCE MORES EMPERATION. DETAIL: SOIL AMENDMENT DETAIL: ROOT BARRIER

SHEET